


1ST FLOOR PLAN OF BLOCK A1  
(SCALE 1:100)

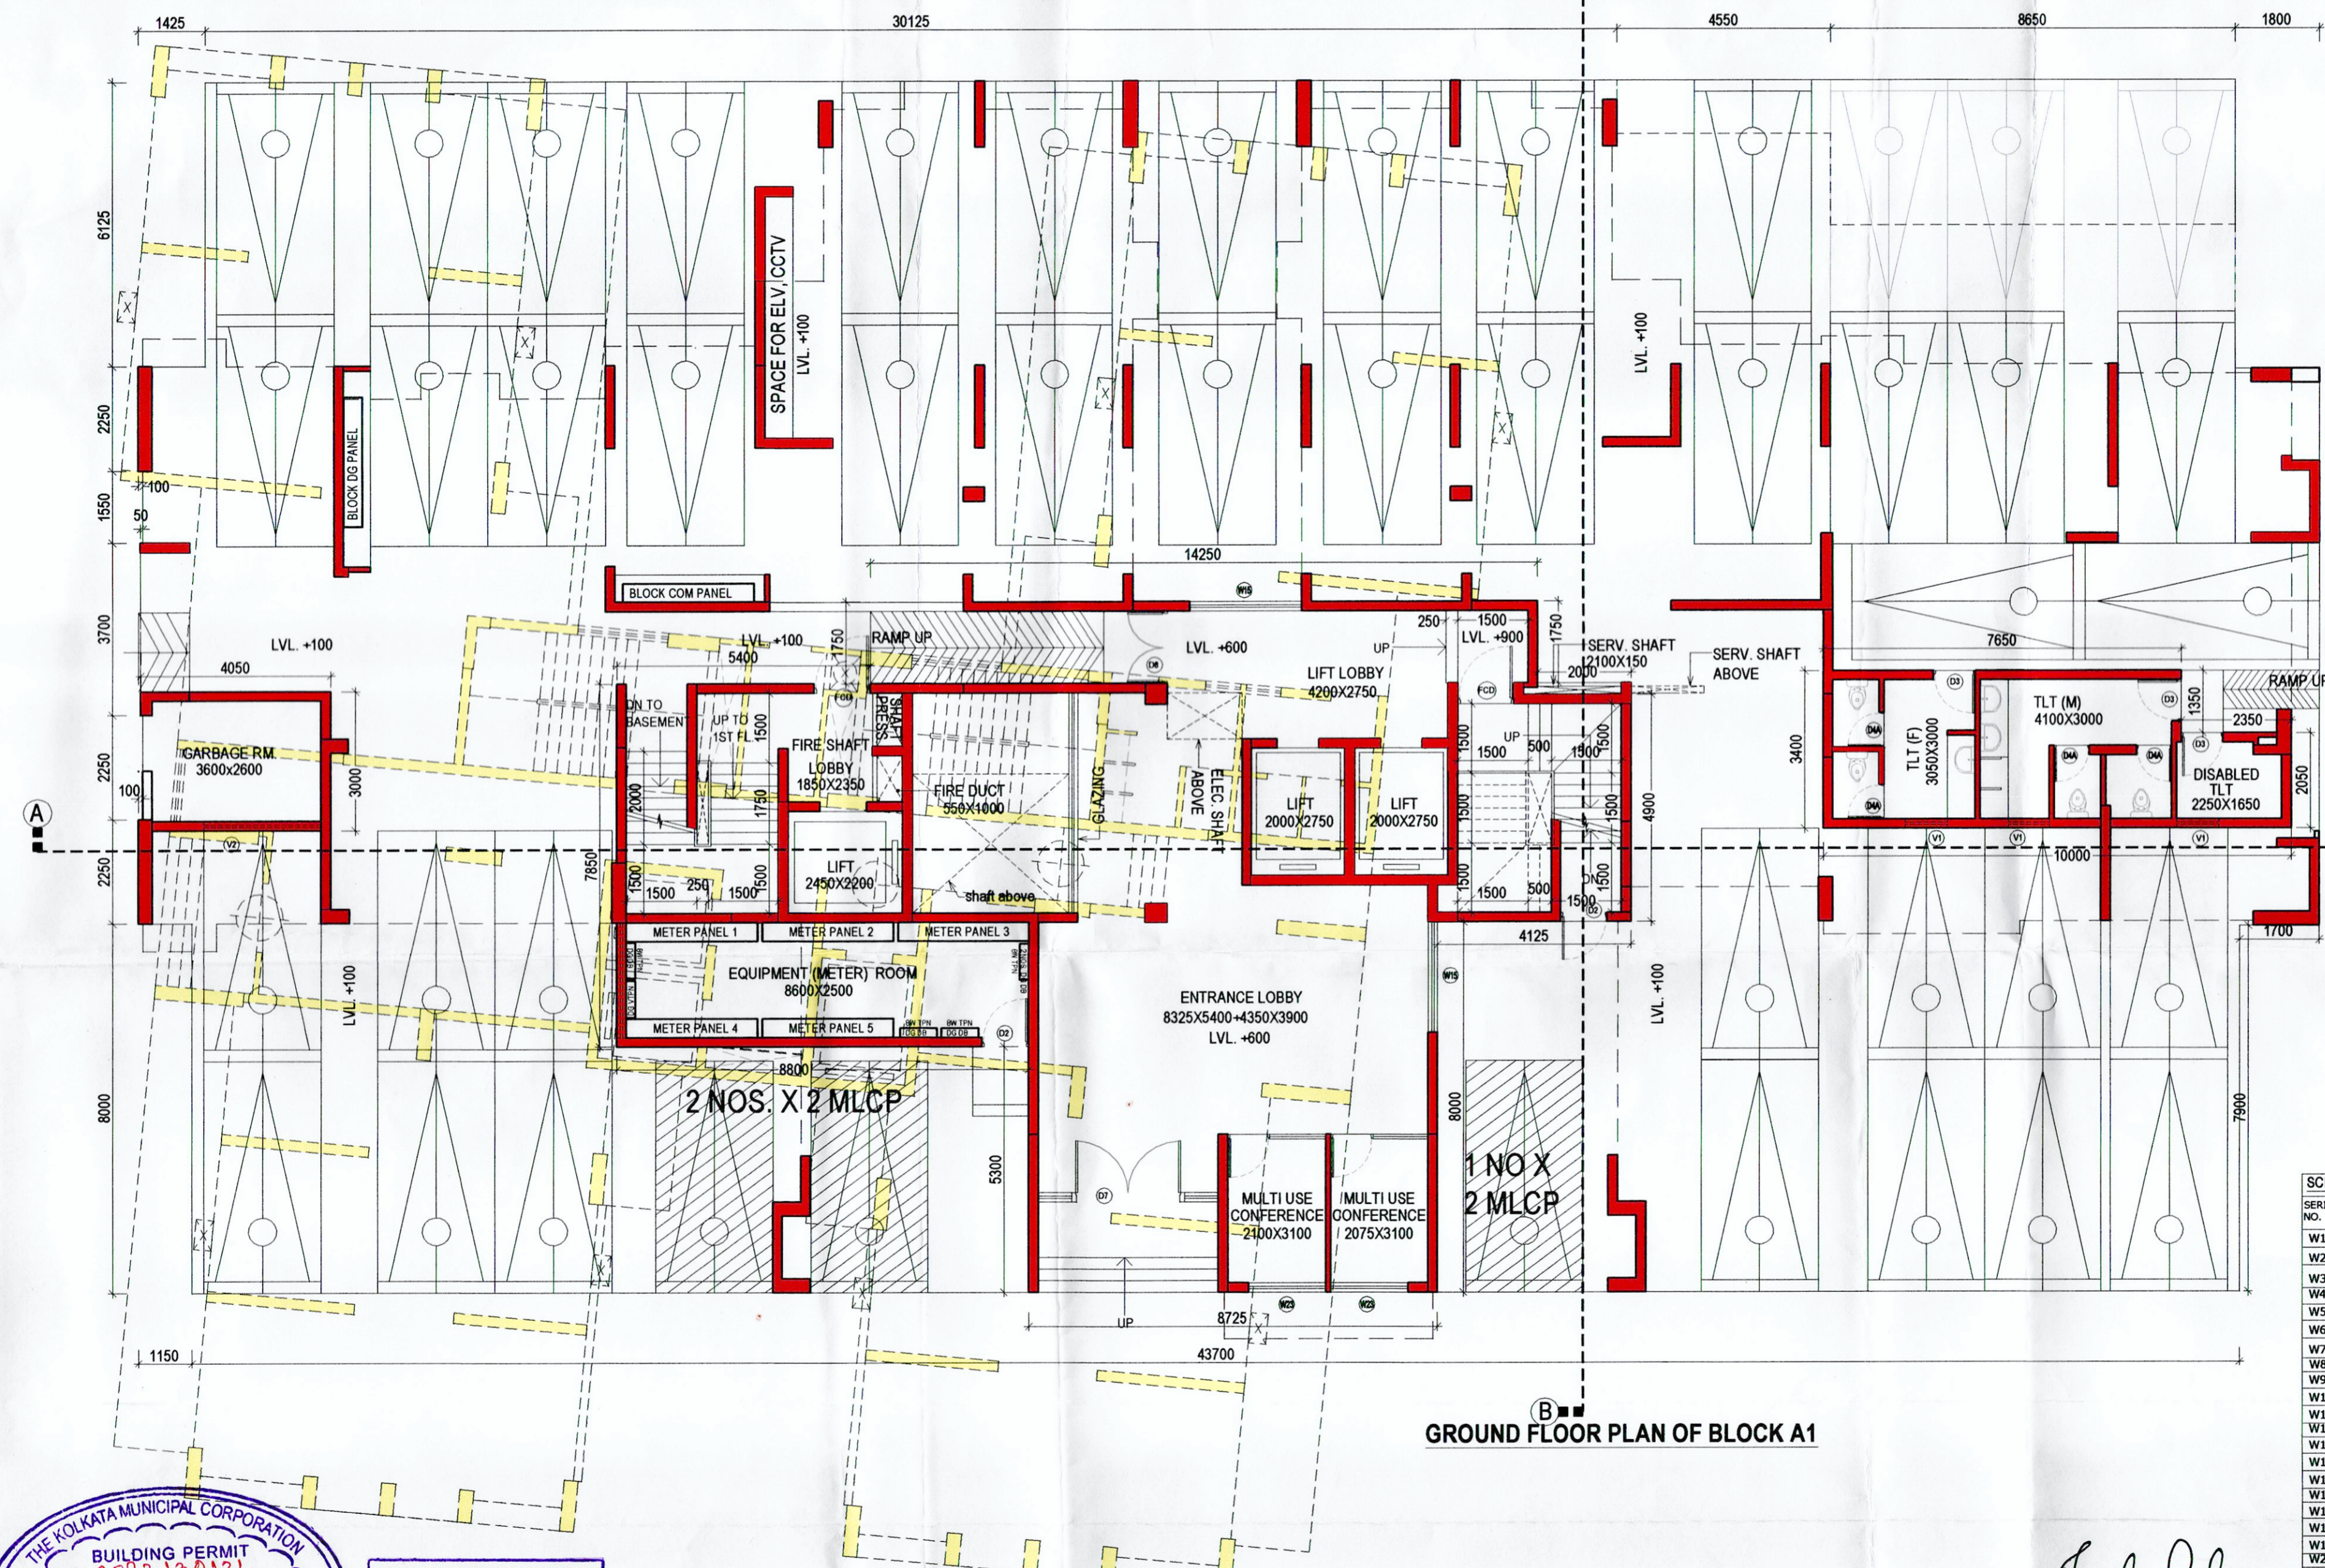

GROUND FLOOR PLAN OF BLOCK A1

MKD.	DOOR DETAIL	WIDTH	HEIGHT	DOOR TYPE
D1	1100	2400	2400	SINGLE SHUTTER FLUSH DOOR
D2	1000	2400	2400	SINGLE SHUTTER FLUSH DOOR
D3	900	2400	2400	SINGLE SHUTTER FLUSH DOOR
D4	800	2400	2400	SINGLE SHUTTER FLUSH DOOR
D5A	750	2400	2400	SINGLE SHUTTER FLUSH DOOR
D6	3500	2400	2400	GLAZING DOOR
D7	1200	2400	2400	SINGLE SHUTTER FLUSH DOOR
D8	2400	2400	2400	DOUBLE SHUTTER FLUSH DOOR
D9	800	2400	2400	DOUBLE SHUTTER FLUSH DOOR
SD1	1550	2400	2400	ALUMINIUM SLIDING DOOR
SD2	3000	2400	2400	ALUMINIUM SLIDING DOOR
SD3	3775	2400	2400	ALUMINIUM SLIDING DOOR
SD4	4275	2400	2400	ALUMINIUM SLIDING DOOR
SD5	2595	2400	2400	ALUMINIUM SLIDING DOOR
SD6	2300	2400	2400	ALUMINIUM SLIDING DOOR
SD7	2400	2400	2400	ALUMINIUM SLIDING DOOR
SD8	1650	2400	2400	ALUMINIUM SLIDING DOOR
SD9	1800	2400	2400	ALUMINIUM SLIDING DOOR
SD10	3000	2400	2400	ALUMINIUM SLIDING DOOR
SD11	3750	2400	2400	ALUMINIUM SLIDING DOOR
SD12	5825	2400	2400	ALUMINIUM SLIDING DOOR
SD13	5475	2400	2400	ALUMINIUM SLIDING DOOR
SD14	2850	2400	2400	ALUMINIUM SLIDING DOOR
SD15	2500	2400	2400	ALUMINIUM SLIDING DOOR
SD17	1475	2400	2400	ALUMINIUM SLIDING DOOR
SD18	3575	2400	2400	ALUMINIUM SLIDING DOOR
FCD	1200	2400	2400	SINGLE SHUTTER FIRE CHC. DOOR

SERIAL NO.	WINDOW DETAIL	WIDTH	HEIGHT	SPECIFICATION	
W1	2050	2300	100	2400	GLAZED ALUMINIUM WINDOW
W2	1000	1500	900	2400	GLAZED ALUMINIUM WINDOW
W3	600	800	1600	2400	ALUMINIUM LOUVER WINDOW
W4	2300	2300	100	2400	GLAZED ALUMINIUM WINDOW
W5	1650	2300	100	2400	GLAZED ALUMINIUM WINDOW
W6	1200	2300	100	2400	GLAZED ALUMINIUM WINDOW
W7	1500	2300	100	2400	GLAZED ALUMINIUM WINDOW
W8	1125	2300	100	2400	GLAZED ALUMINIUM WINDOW
W9	2975	2300	100	2400	GLAZED ALUMINIUM WINDOW
W10	2400	2300	100	2400	GLAZED ALUMINIUM WINDOW
W11	1800	2300	100	2400	GLAZED ALUMINIUM WINDOW
W12	3000	2300	100	2400	GLAZED ALUMINIUM WINDOW
W13	3750	2300	100	2400	GLAZED ALUMINIUM WINDOW
W14	2400	2300	100	2400	GLAZED ALUMINIUM WINDOW
W15	2400	2300	900	2400	GLAZED ALUMINIUM WINDOW
W16	4050	2300	100	2400	GLAZED ALUMINIUM WINDOW
W17	2850	2300	100	2400	GLAZED ALUMINIUM WINDOW
W18	2500	2300	100	2400	GLAZED ALUMINIUM WINDOW
W19	3475	2300	100	2400	GLAZED ALUMINIUM WINDOW
W20	1550	1500	900	2400	GLAZED ALUMINIUM WINDOW
W21	1750	1500	900	2400	GLAZED ALUMINIUM WINDOW
W22	1725	1500	900	2400	GLAZED ALUMINIUM WINDOW
W23	1650	1500	900	2400	GLAZED ALUMINIUM WINDOW
V1	900	750	-	2400	ALUMINIUM LOUVER WINDOW
V2	2500	750	-	2400	ALUMINIUM LOUVER WINDOW

**BUILDING PERMIT**  
No. 2017/2362  
Date: 11/12/2020, Borough No. 1111  
Ex. Engineer (Asst. Engineer)  
Bor. No. 1111, Bor. No. 1111  
\*BUILDING DEPARTMENT\*

THE SANCTION IS VALID UP TO... 17/9/2028  
Approved by M.B.C.  
dt. 11/12/2020

**APPROVED**  
ASSISTANT ENGINEER (C)  
BOROUGH No. 1111

**JISHNU PAI**  
B.Tech (Civil), M.E (Geo-tech)  
KMC Reg. No. G.T/17/32  
G.T.E./KMCDA/10/0043  
22/RJSON/G-T-1/2016-17  
HMC Reg. No. EGTE/CLASS-1/15

**DECLARATION BY OWNER & ARCHITECT**  
I CERTIFY THAT THE BUILDING PLAN HAS BEEN DRAWN UP AS PER PROVISION OF K.M.C. BUILDING RULE 2009 AS AMENDED FROM TIME TO TIME. THE SITE CONDITION INCLUDING THE WIDTH OF THE ABUTTING K.M.C ROAD OF AVG. 10.05 M. ON EAST HAS BEEN CONFIRMED WITH THE PLAN. IT IS A BUILDABLE SITE, NOT A TANK OR FILLED UP TANK. SITE MEASUREMENT IS AS PER REGISTERED BOUNDARY DECLARATION.

**DECLARATION BY STRUCTURAL ENGINEER**  
THE STRUCTURAL DESIGNS AND DRAWINGS OF BOTH FOUNDATION AND SUPERSTRUCTURE OF THE BUILDING HAS BEEN MADE BY ME CONSIDERING THE SOIL TEST REPORT (AS PER THESE RULES AND THE REGULATIONS MADE UNDER THE ACT) MADE BY MR. J. PAUL FROM SKM GEOSURVEY AND ALSO CONSIDERING ALL POSSIBLE LOADS INCLUDING THE SEISMIC LOAD AS PER NATIONAL BUILDING CODE OF INDIA AND CERTIFY THAT IT IS SAFE AND STABLE IN ALL RESPECTS.

**PROJECT**  
RESIDENTIAL BUILDING U/R 394 OF KMC FOR PROPOSED BLOCKS A1 & A2 B+(G+18) STORIED AND EXISTING BLOCKS B1 & B2, B+(G+17) & A3 AND A4 (G+19) STORIED HIGH RESIDENTIAL BUILDING AT 88 A, B.L.SAHA ROAD, BOROUGH NO.- XIII, WARD NO.- 116, KOLKATA - 700053 VIDE BS NO. 2017130170, DT 01.12.2017 AND 20/U/R-26(2a) AND (2b)/2019-2020 dt- 03/12/2019

**NOTES**  
- ALL DIMENSIONS ARE IN MM  
- ALL EXTERNAL WALLS ARE 200 THK. AND ALL INTERNAL WALLS ARE 100MM AND 125MM THK BRICK WALL, UNLESS OTHERWISE MENTIONED.  
- ALL P.C.C. WORK IN 1 : 3 : 6  
- ALL R.C.C. WORK IN 1 : 2 : 4  
- ALL OTHER SPECIFICATIONS CONFORMING RELEVANT I.S.I. CODE  
- INTERNAL ROAD LEVELS ARE (+)150 MM FROM

signature of Architect  
**Sanjay Mandal**  
COA Registration No.: CA / 98 / 23621

signature of Owner  
For Sugam Griha Nirman Ltd.  
Director  
For Self and as Constituted Attorney of  
1. Orbit Towers Pvt. Ltd.  
2. Goodluck Infradevelopers Pvt. Ltd.  
3. Super Diamond Nirman Pvt. Ltd.

signature of Structural Engineer  
**Utpal Santra**  
UTPAL SANTRA  
B.C.E., M.C.E.(STRUCT.)  
FIE: P212601  
KMC: Empanelled Structural Engineer  
Class-4, E.S.E. No. 1/56  
signature of Structural Reviewer  
Signature of Structural Reviewer

**TITLE**  
GROUND & 1ST FLOOR PLANS OF BLOCK A1  
**DWG. No.** IN/1171/CORP2/ARIA101  
**SCALE** 1:100  
**DATE** 15.12.2020  
**JOB No.** IN / 1171  
**ISSUE STATUS**  
**DRAWN BY** S.S.  
**CHECKED BY** M.K.  
**APPVD. BY** A.B.  
**SANCTION**

**ARCHITECT**  
26/2 Ballygunge Circular Road,  
Kolkata 700019  
www.innateindia.com  
tel: (033) 4000 6424 / 25 26  
**INNATE**  
ARCHITECTS PLANNERS  
ENGINEERS